
INDEX TO SHEETS

SHEET NO.	DESCRIPTION
-	TITLE SHEET
-	TOPOGRAPHIC SURVEY
L1.0	PROJECT MASTER PLAN
L2.0	HARDSCAPE SITE FEATURES
L3.0	LANDSCAPE PLANTING PLAN
L4.0	LANDSCAPE FEATURE DETAILS
L5.0	LANDSCAPE NOTES & DETAILS

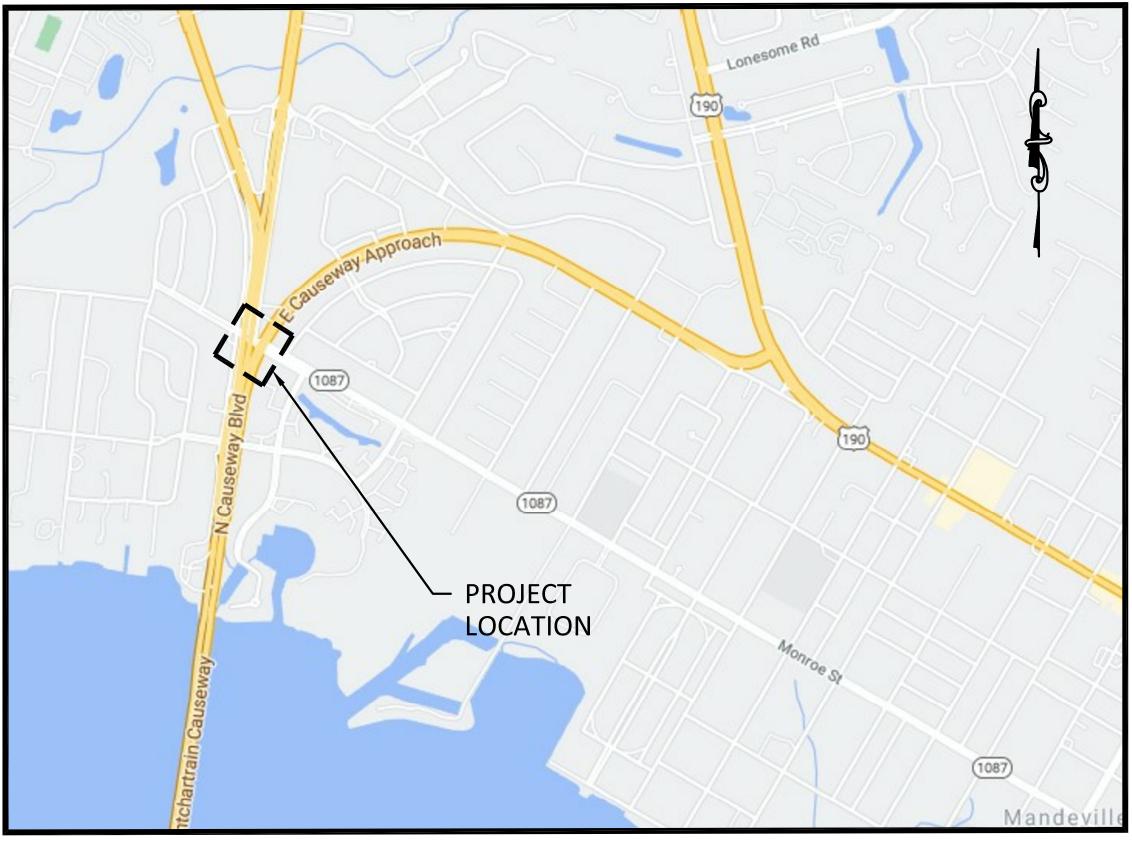

CITY OF MANDEVILLE MONROE STREET UNDERPASS at CAUSEWAY BOULEVARD LANDSCAPE IMPROVEMENTS MANDEVILLE, LOUISIANA

SITE MAP SCALE: 1 INCH = 1000 FEET

SCALE IN FEET

JANUARY 25, 2021





KYLE ASSOCIATES PROJECT NO. 20054



SCALE: 1 INCH = 15 MILES



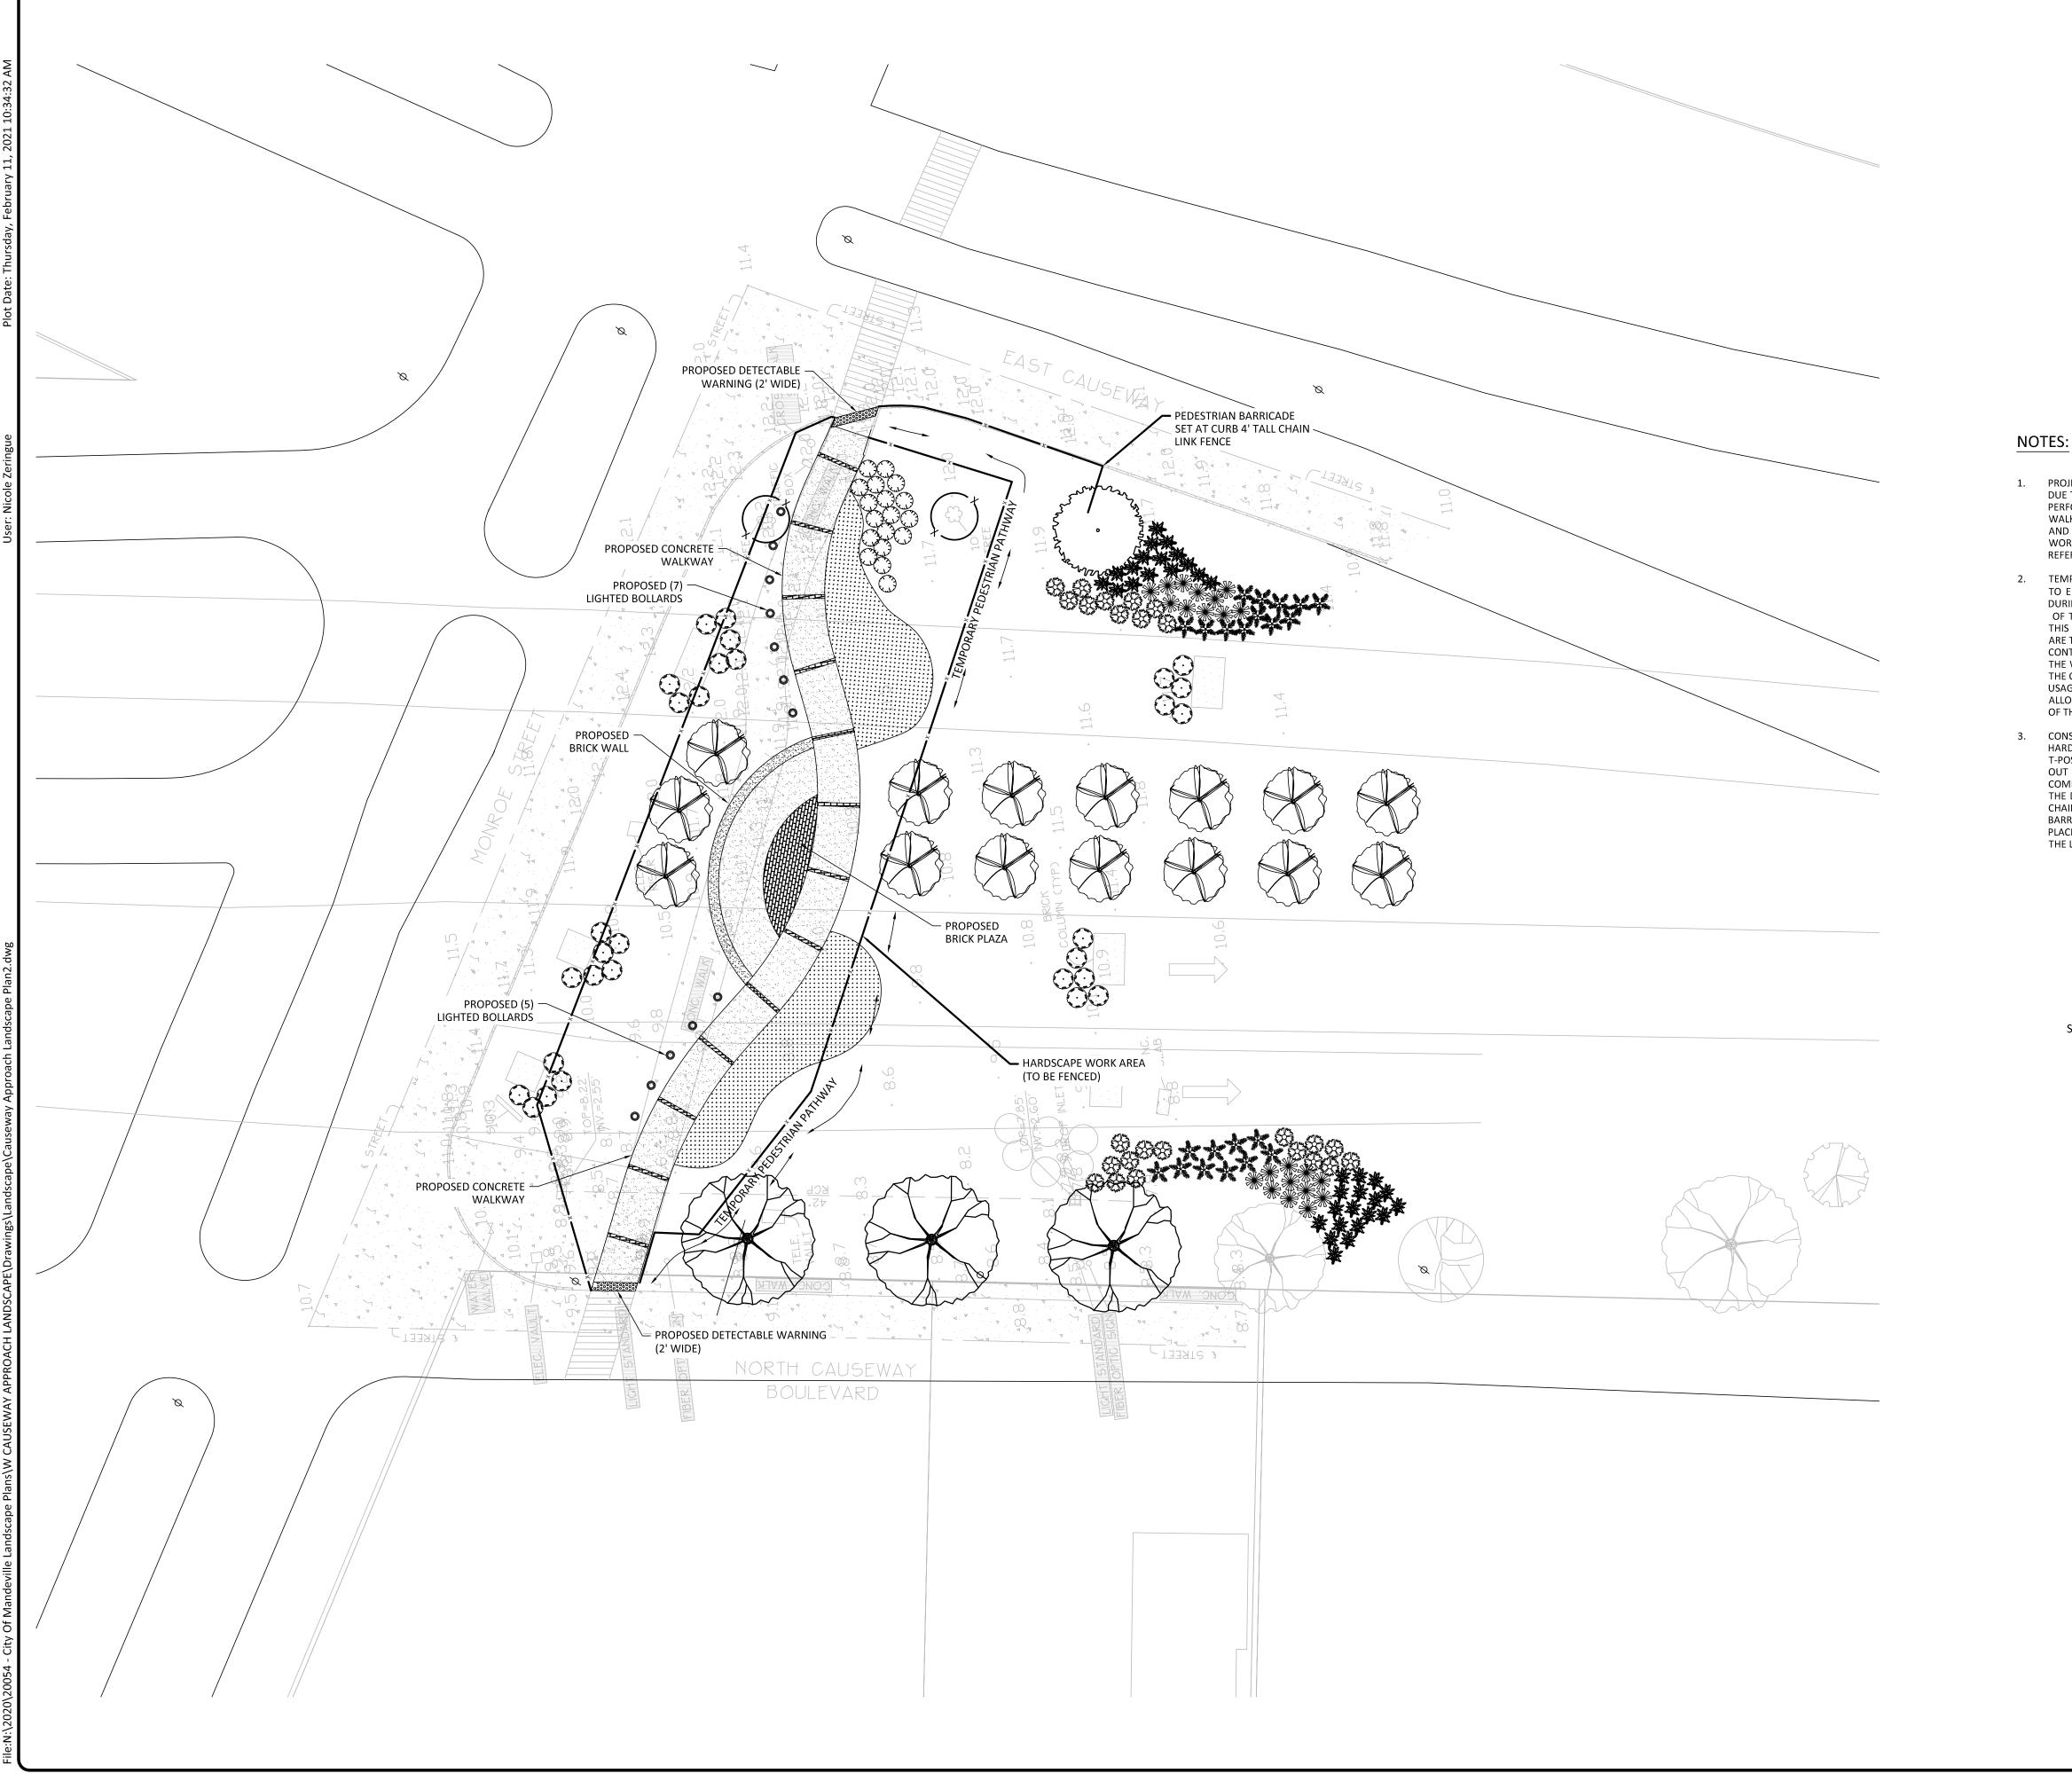

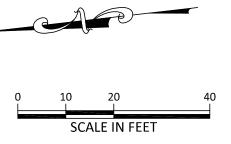

1. PROJECT SEQUENCING


DUE TO THE DISRUPTION OF THE PEDESTRIAN CORRIDOR BY THIS PROJECT, THE CONTRACTOR IS TO PERFORM THE HARDSCAPE PORTION OF THE PROJECT - DEMOLITION AND CONSTRUCTION OF NEW WALKWAY, BRICK PLAZA, AND BRICK WALL - PRIOR TO THE COMMENCEMENT OF ANY PERIPHERAL AND LANDSCAPE WORK. THE INTENT IS TO HAVE THE NEW WALKWAY AND OTHER HARDSCAPE WORK COMPLETED AS SOON AS POSSIBLE SO THAT FACILITY CAN BE REOPENED TO THE PUBLIC. REFER TO NOTE 2 FOR PEDESTRIAN TRAFFIC FLOW.

TEMPORARY PEDESTRIAN ACCESS

TO ENSURE THE EAST/WEST PEDESTRIAN FLOW ACROSS CAUSEWAY BOULEVARD IS MAINTAINED DURING THE CONSTRUCTION OF THIS PROJECT, CONSTRUCTION FENCING IS TO BE PLACED ON THE OF THE CONSTRUCTION ZONE (AS INDICATED, THIS SHEET) TO PREVENT PEDESTRIAN ACCESS TO THIS ZONE. DURING CONSTRUCTION OF THE HARDSCAPE PORTION OF THE PROJECT, PEDESTRIANS ARE TO BE ROUTED TO THE SOUTH THIS FENCING, AROUND THE HARDSCAPE CONSTRUCTION ZONE. CONTRACTOR IS TO PROVIDE VISUAL DIRECTION SIGNAGE INDICATING THE SAFE PASSAGE AROUND THE WORK AREA. UPON COMPLETION OF THE HARDSCAPE SCOPE OF WORK, AND ACCEPTANCE BY THE CITY AND LANDSCAPE ARCHITECT, THE NEW SIDEWALK WILL BE OPENED FOR PEDESTRIAN USAGE WHILE THE LANDSCAPE PORTION OF THE PROJECT IS COMPLETED. NO ACCESS WILL BE ALLOWED TO THE NEW HARDSCAPE WORK WITHOUT THE WRITTEN PERMISSION AND ACCEPTANCE OF THAT WORK HAS BEEN ISSUED.


CONSTRUCTION FENCING

HARDSCAPE WORK AREA IS TO BE FENCED USING 3' TALL ORANGE SAFETY FENCING SECURED WITH T-POSTS AS NEEDED TO SECURE THE CONSTRUCTION SITE. FENCE IS TO BE MAINTAINED THROUGH-OUT THE CONSTRUCTION PERIOD AND UNTIL THE HARDSCAPE PORTION OF THE PROJECT IS COMPLETED AND ACCEPTED. CONTRACTOR IS TO ENSURE THE SECURITY OF THE WORK AREA FOR THE DURATION OF THE PROJECT. ADDITIONALLY, CONTRACTOR IS TO PLACE 70 LINEAR FEET OF 4' CHAIN LINK ALONG THE CURBING OF EAST CAUSEWAY BLVD, AS SHOWN THIS SHEET, TO SERVE AS A BARRIER TO PEDESTRIANS NAVIGATING AROUND THE WORK ZONE. THIS FENCING IS TO REMAIN IN PLACE UNTIL THE PROJECT IS 100% COMPLETED AND ACCEPTED BY THE CITY OF MANDEVILLE AND THE LANDSCAPE ARCHITECT.

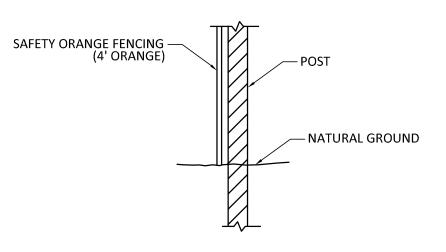


CONSTRUCTION FENCING SECTION


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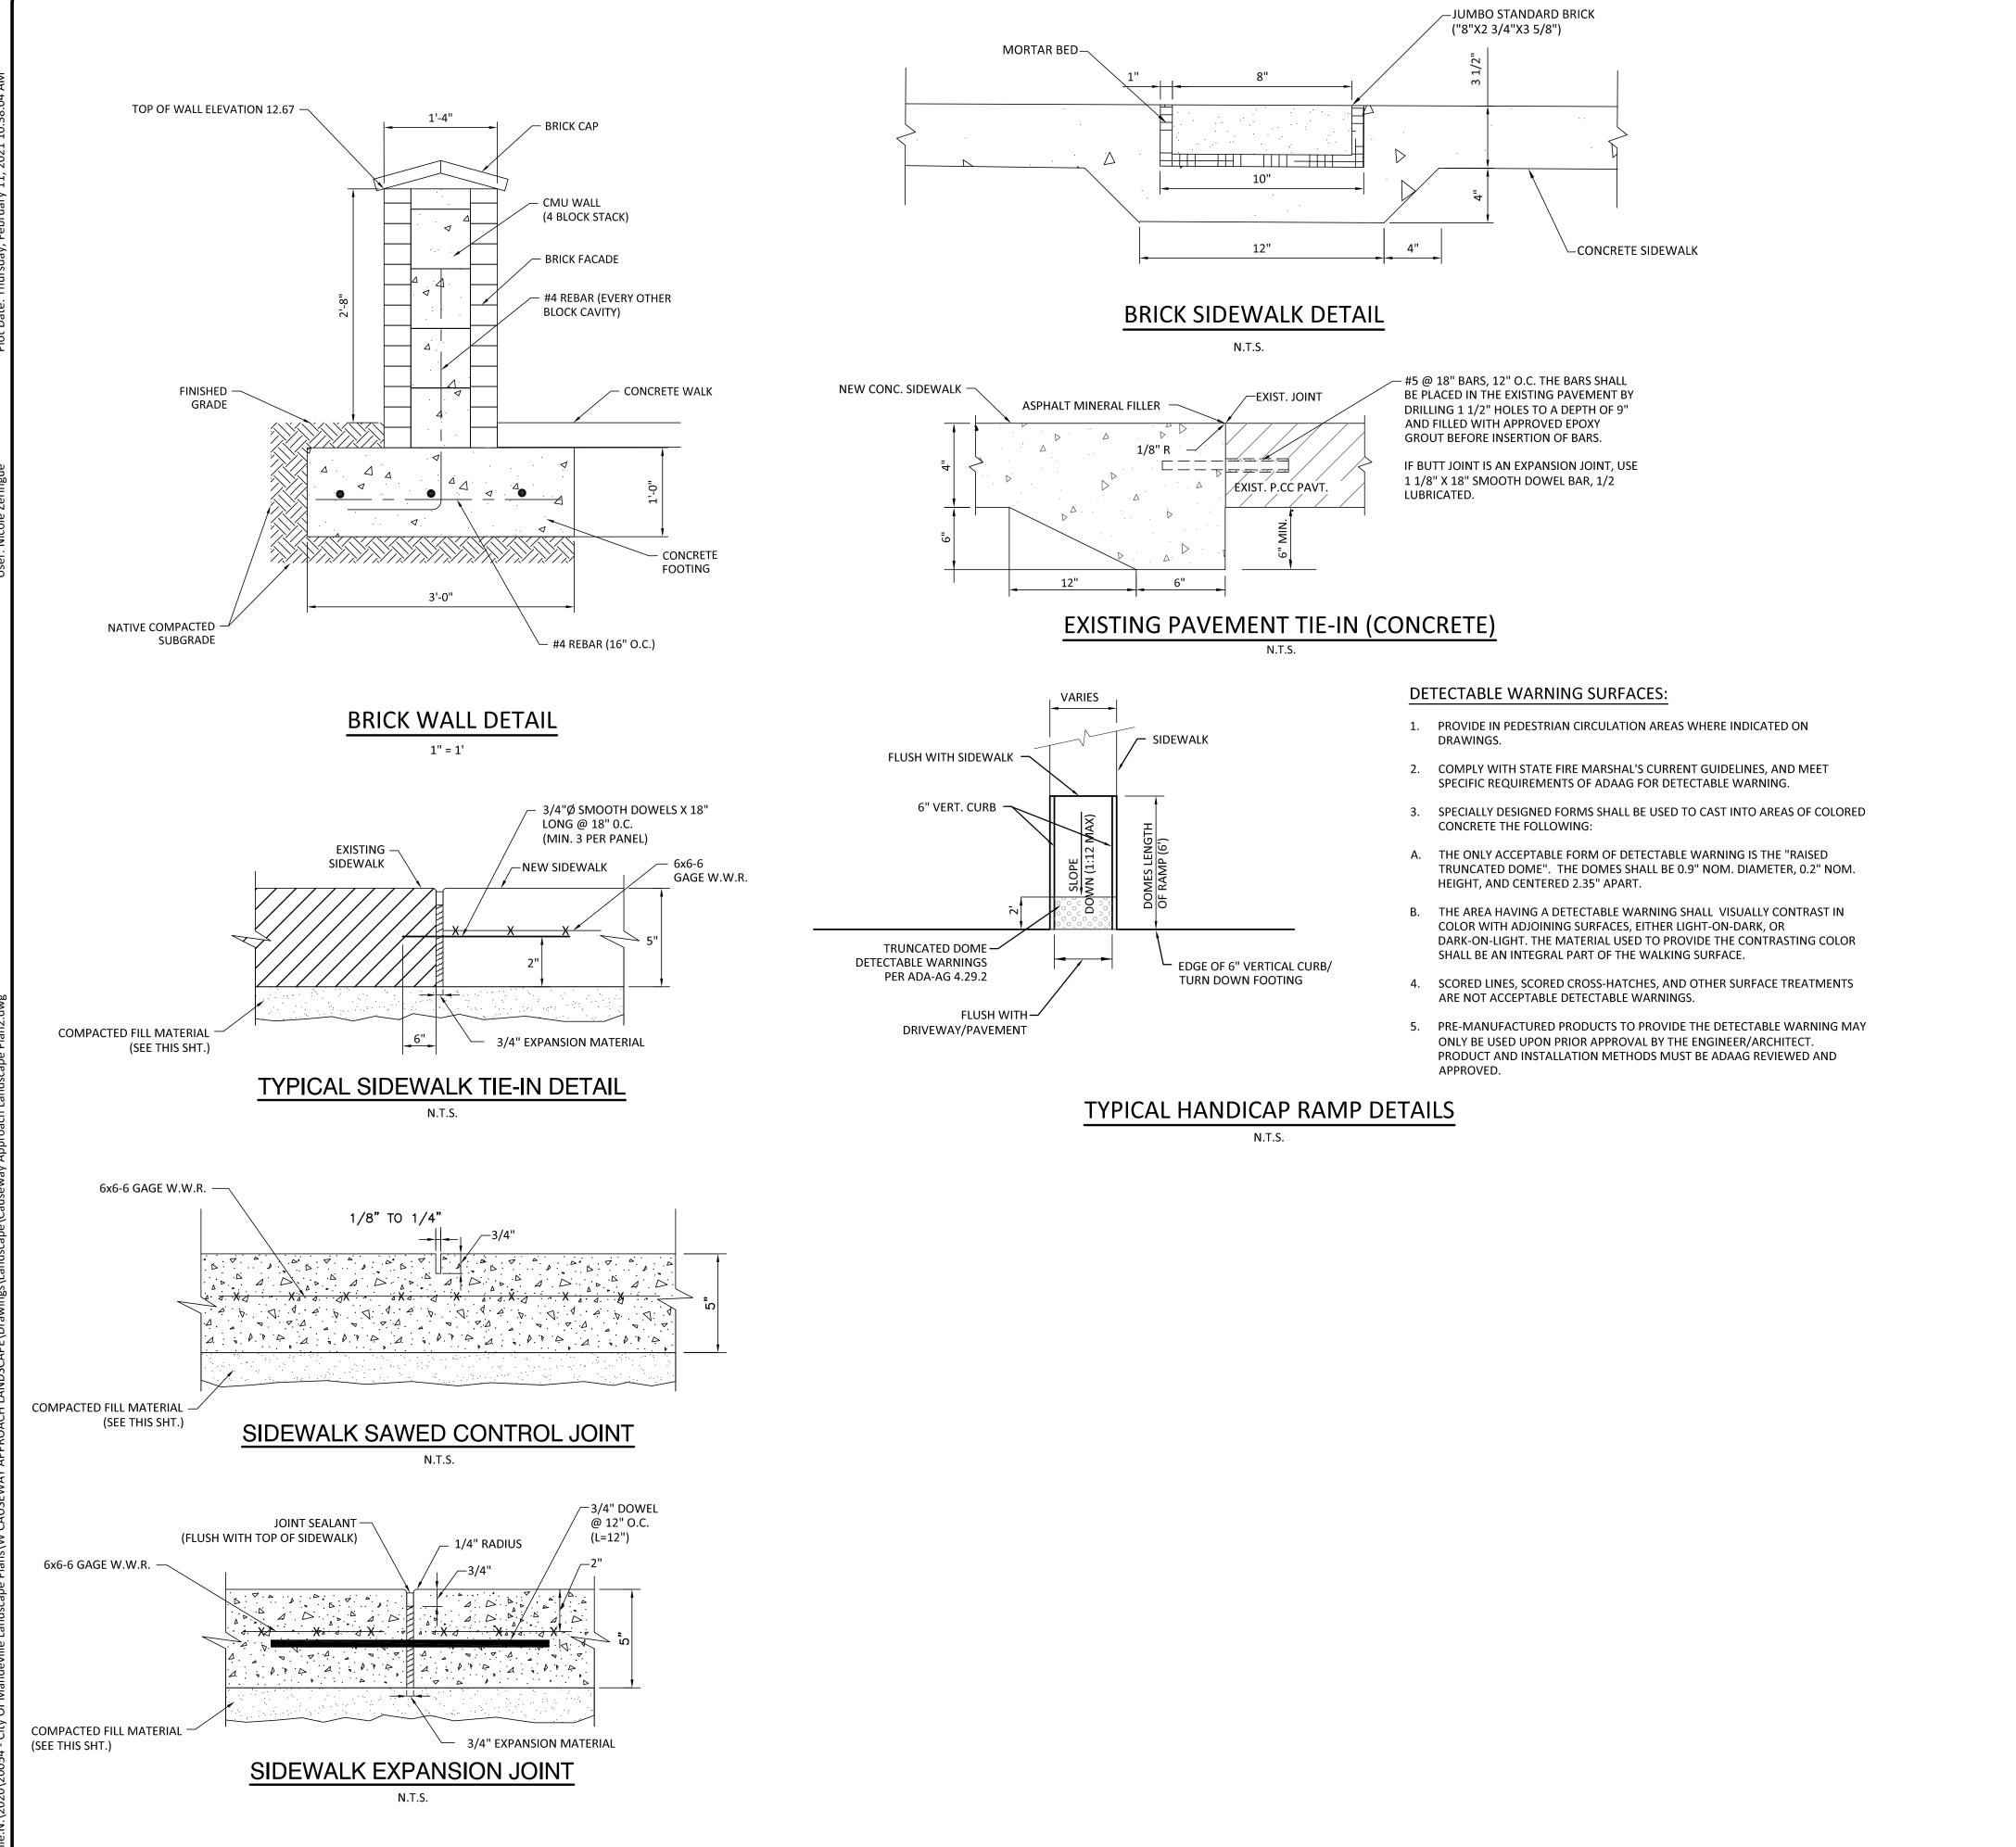


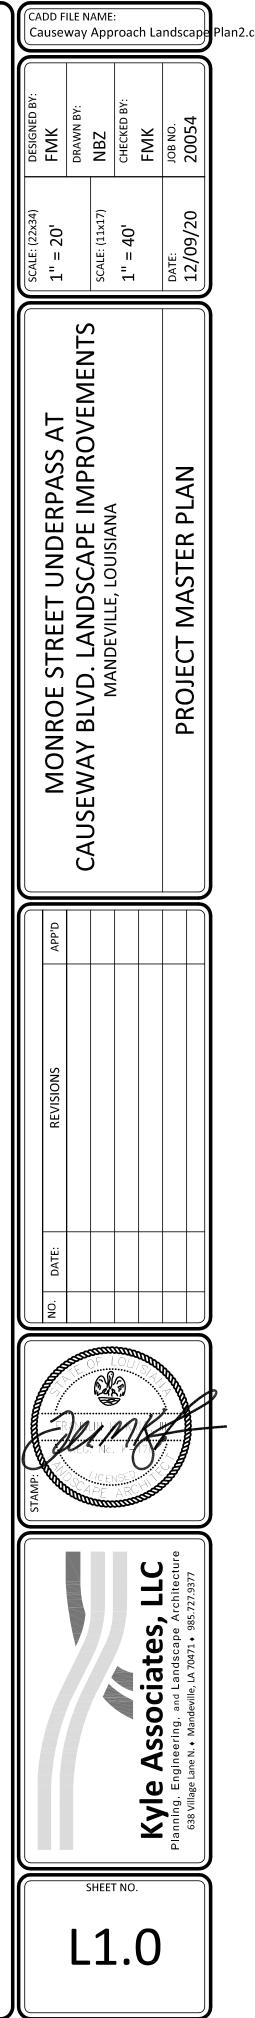LEGEND:	CADD FILE NAME: Causeway Approach Landscape Plan2.c
2 13.19 PROPOSED GRADE (TOP OF SIDEWALK)	DESIGNED BY: FMK PRAWN BY: DRAWN BY: NBZ CHECKED BY: FMK FMK JOB NO. 20054
EXISTING GRADES	
M.E. MATCH EXISTING GRADE	Tix17) 0 1 1x17) 0 100
25 X FINISHED GRADE	ECALE: (22x34) SCALE: (22x34) 1" = 20' SCALE: (11x17) 1" = 40' DATE: DATE: 12/09/20
BERM FILL NOTES:	STI
CTOR IS TO PERFORM FINE GRADING FOR ALL PLANTING /ITH TOPSOIL FREE OF DEBRIS AND SUITABLE FOR SOD OR 'LANTING, AS APPLICABLE. FILL MATERIAL IS TO BE GRADED IRE PROPER DRAINAGE AWAY FROM PAVED SURFACE.	MONROE STREET UNDERPASS AT WAY BLVD. LANDSCAPE IMPROVEMENTS MANDEVILLE, LOUISIANA HARDSCAPE SITE FEATURES
G BERMS ARE TO BE FILLED TO THE ELEVATIONS INDICATED. ERIAL IS TO BE FREE OF ALL DEBRIS AND SUITABLE FOR THE ATERIAL SPECIFIED.	ASS / APRO URES
APE ARCHITECT IS TO APPROVE HEIGHT AND SHAPE OF ALL G BERMS PRIOR TO THE SETTING AND INSTALLATION OF IATERIAL.	ADERPASS APE IMPRC JISIANA FEATURES
<u>S:</u>	SITE SITE
DS ARE TO BE FOREVER BRIGHT MODEL# SPJ-R12, OR ED EQUAL. CONTRACTOR IS TO SUBMIT CUT SHEETS ON ED BOLLARDS FOR APPROVAL PRIOR TO SECURING AL.	NROE STREE Y BLVD. LAN MANDEVIL
C SERVICE IS TO BE PROVIDED BY THE CITY OF MANDEVILLE, SOURCE TO BE OF OR NEAR THE EXISTING POWER RISER O NEAR MONROE STREET.	
IED WIRING IS TO BE PLACED IN CONDUIT. CAL WORK IS TO BE PERFORMED IN ACCORDANCE WITH ALL	M M M M M M M M M M M M M M M M M M M
ND STATE CODES GOVERNING WORK OF THIS TYPE. ARDS AND OTHER ELECTRICAL EQUIPMENT IS TO BE ED PER MANUFACTURERS SPECIFICATIONS. IN THE EVENT OF ICT BETWEEN THESE SPECIFICATIONS AND LOCAL CODE, THE APE ARCHITECT IS TO BE CONTACTED IMMEDIATELY.	CAUSEWAY
OMETRIC SWITCH IS TO BE PROVIDED TO OPERATE ALL DS, COMING ON AT DUSK AND OFF AT DAYLIGHT.	Q,ddV
SWITCH IS TO BE LOCATED AT THE ELECTRICAL RISER.	AA
	SNO
	REVISIONS
	DATE:
Model: SPJ-R12	<u><u><u></u></u></u>
Finish: Concrete	
	AMA
Concrete Bollard	IN THE ARGUNATION
20V Consult customer service) ent, HID or LED solted	LLC LLC .727.9377
Inchor Bolt	
Plate 42"	Sociate Mandeville, LA 70471
	Planning.
LIGHTED BOLLARD DETAIL	SHEET NO.
N.T.S.	L2.0



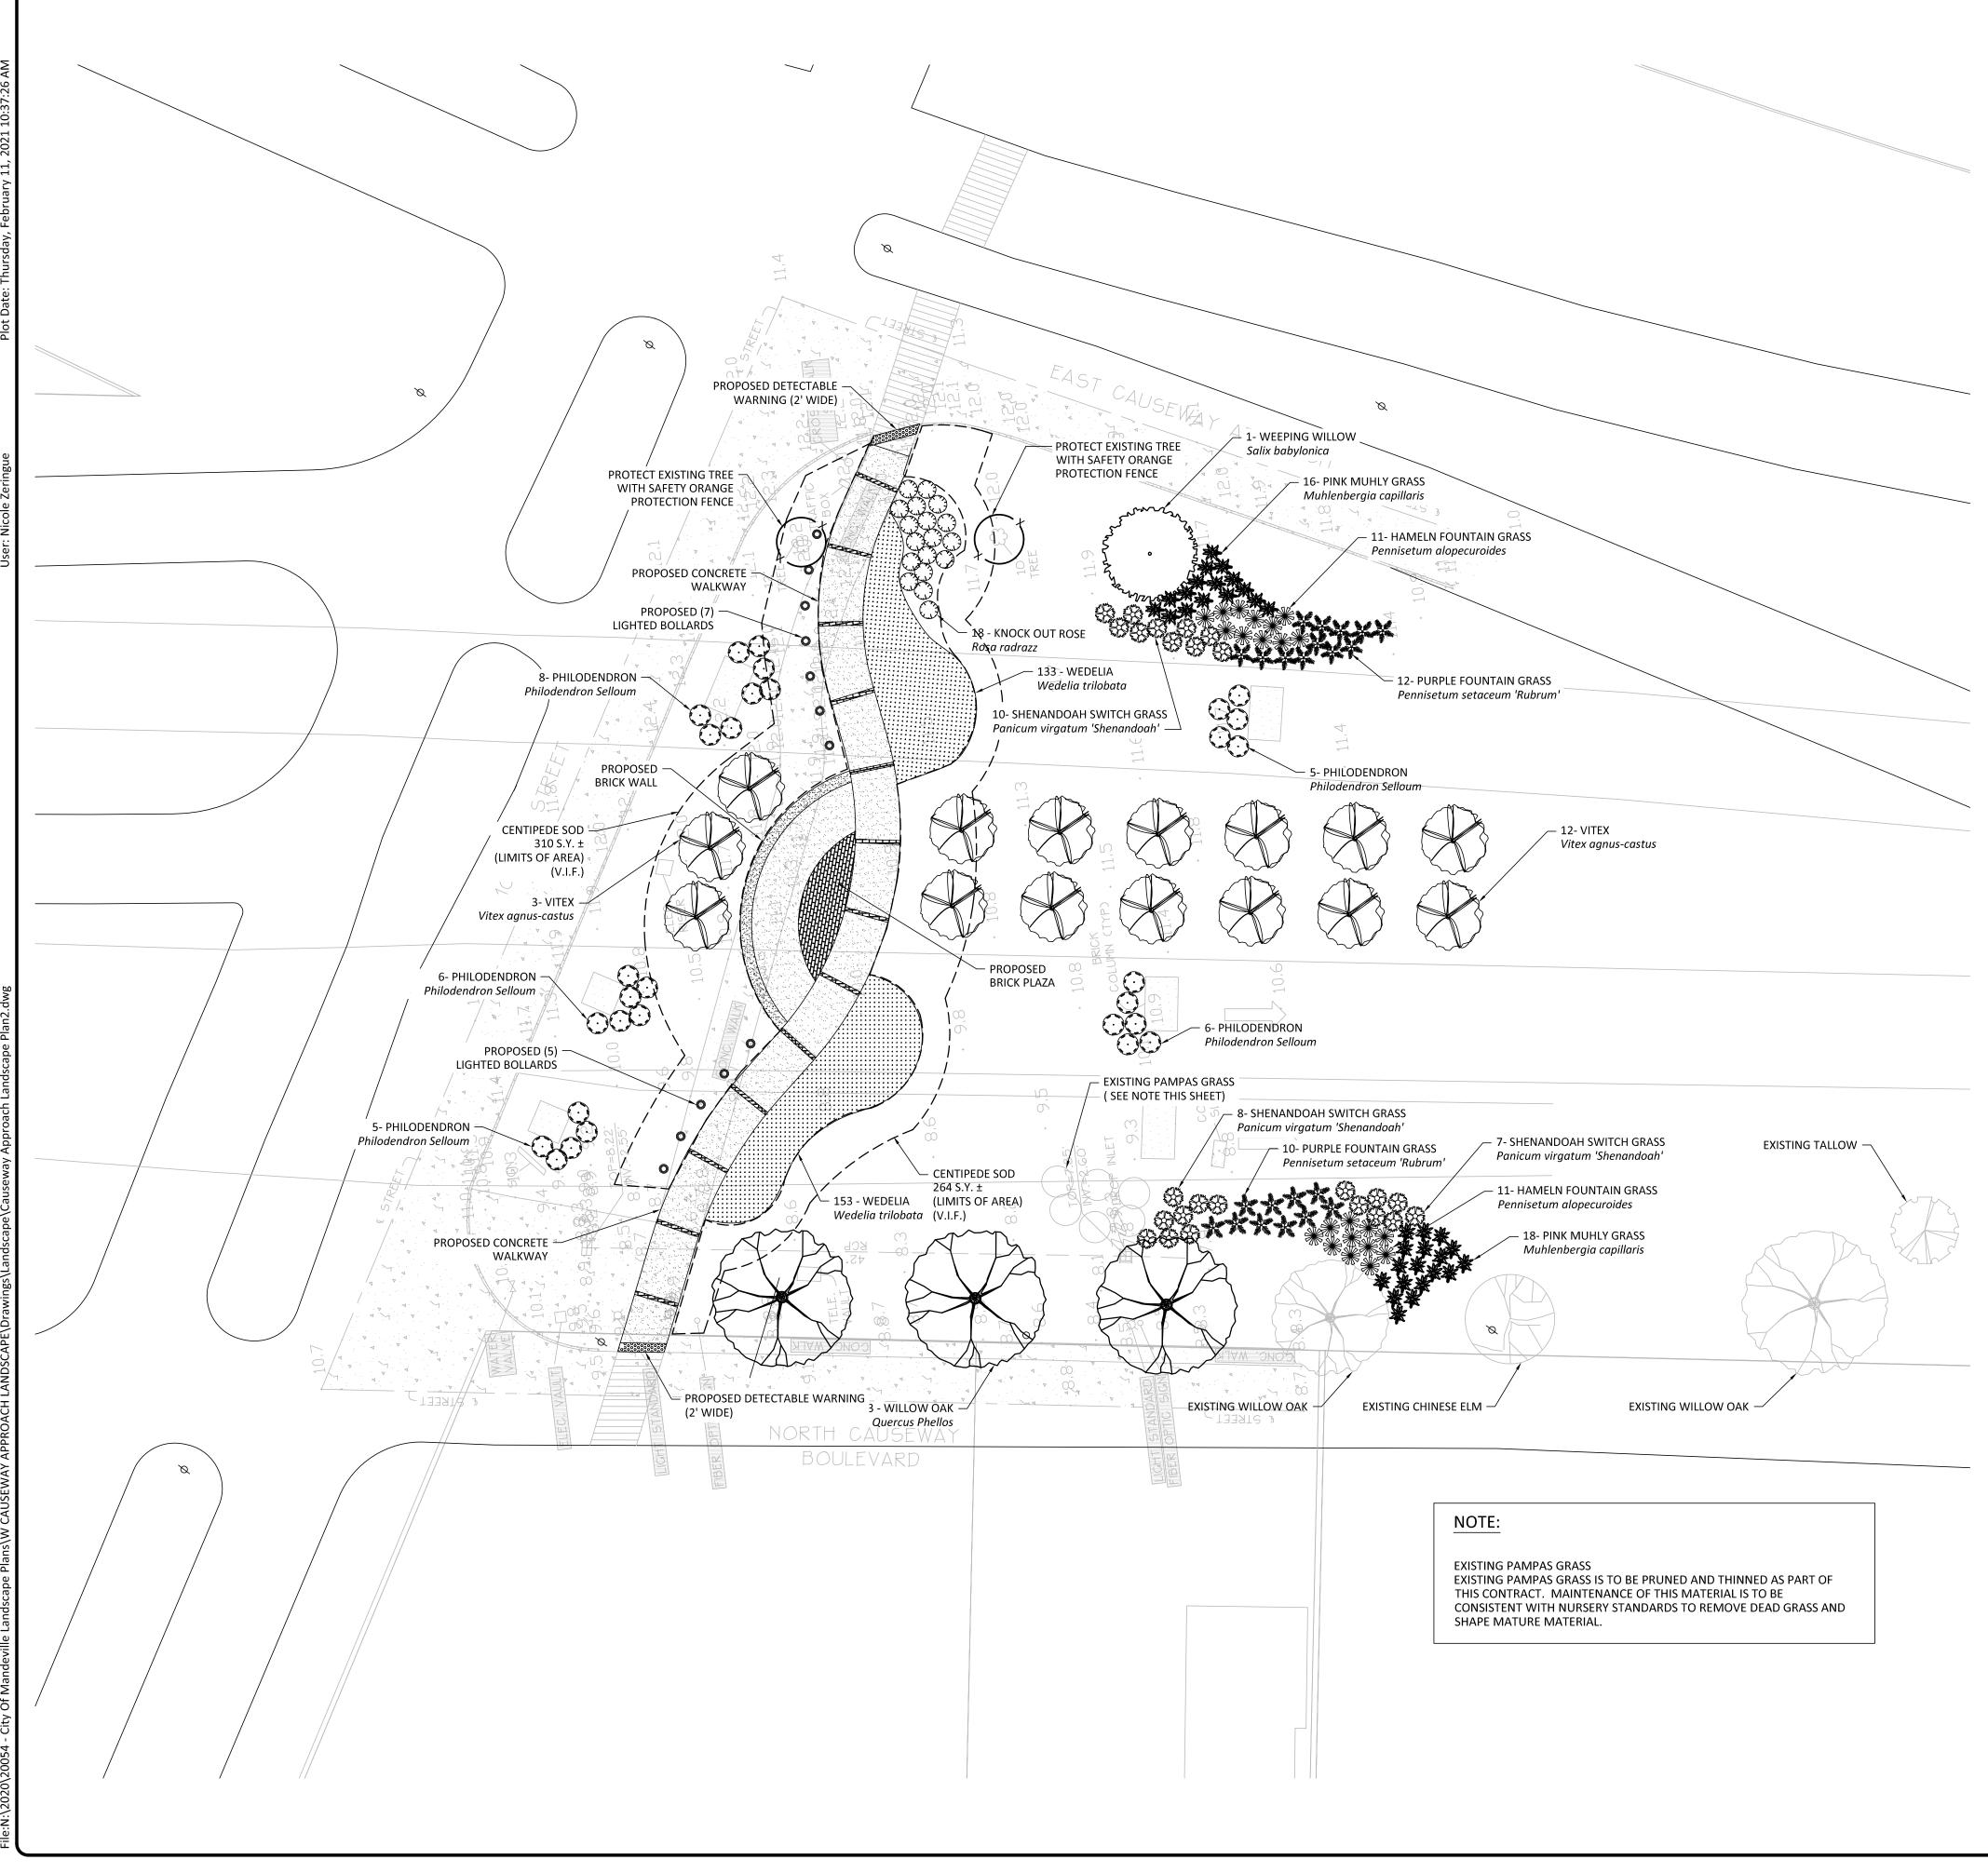

SCALE IN FEET

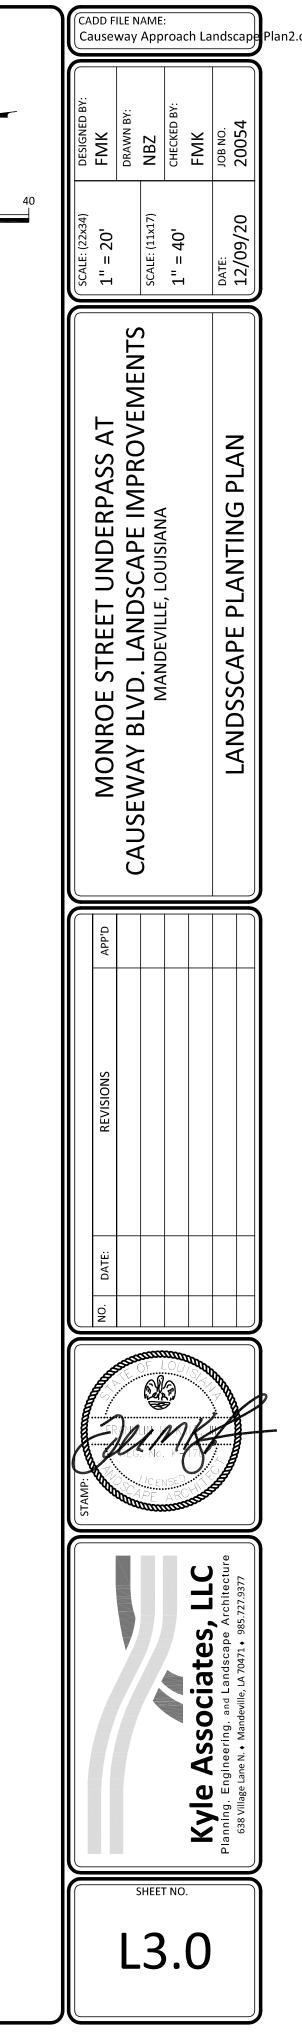

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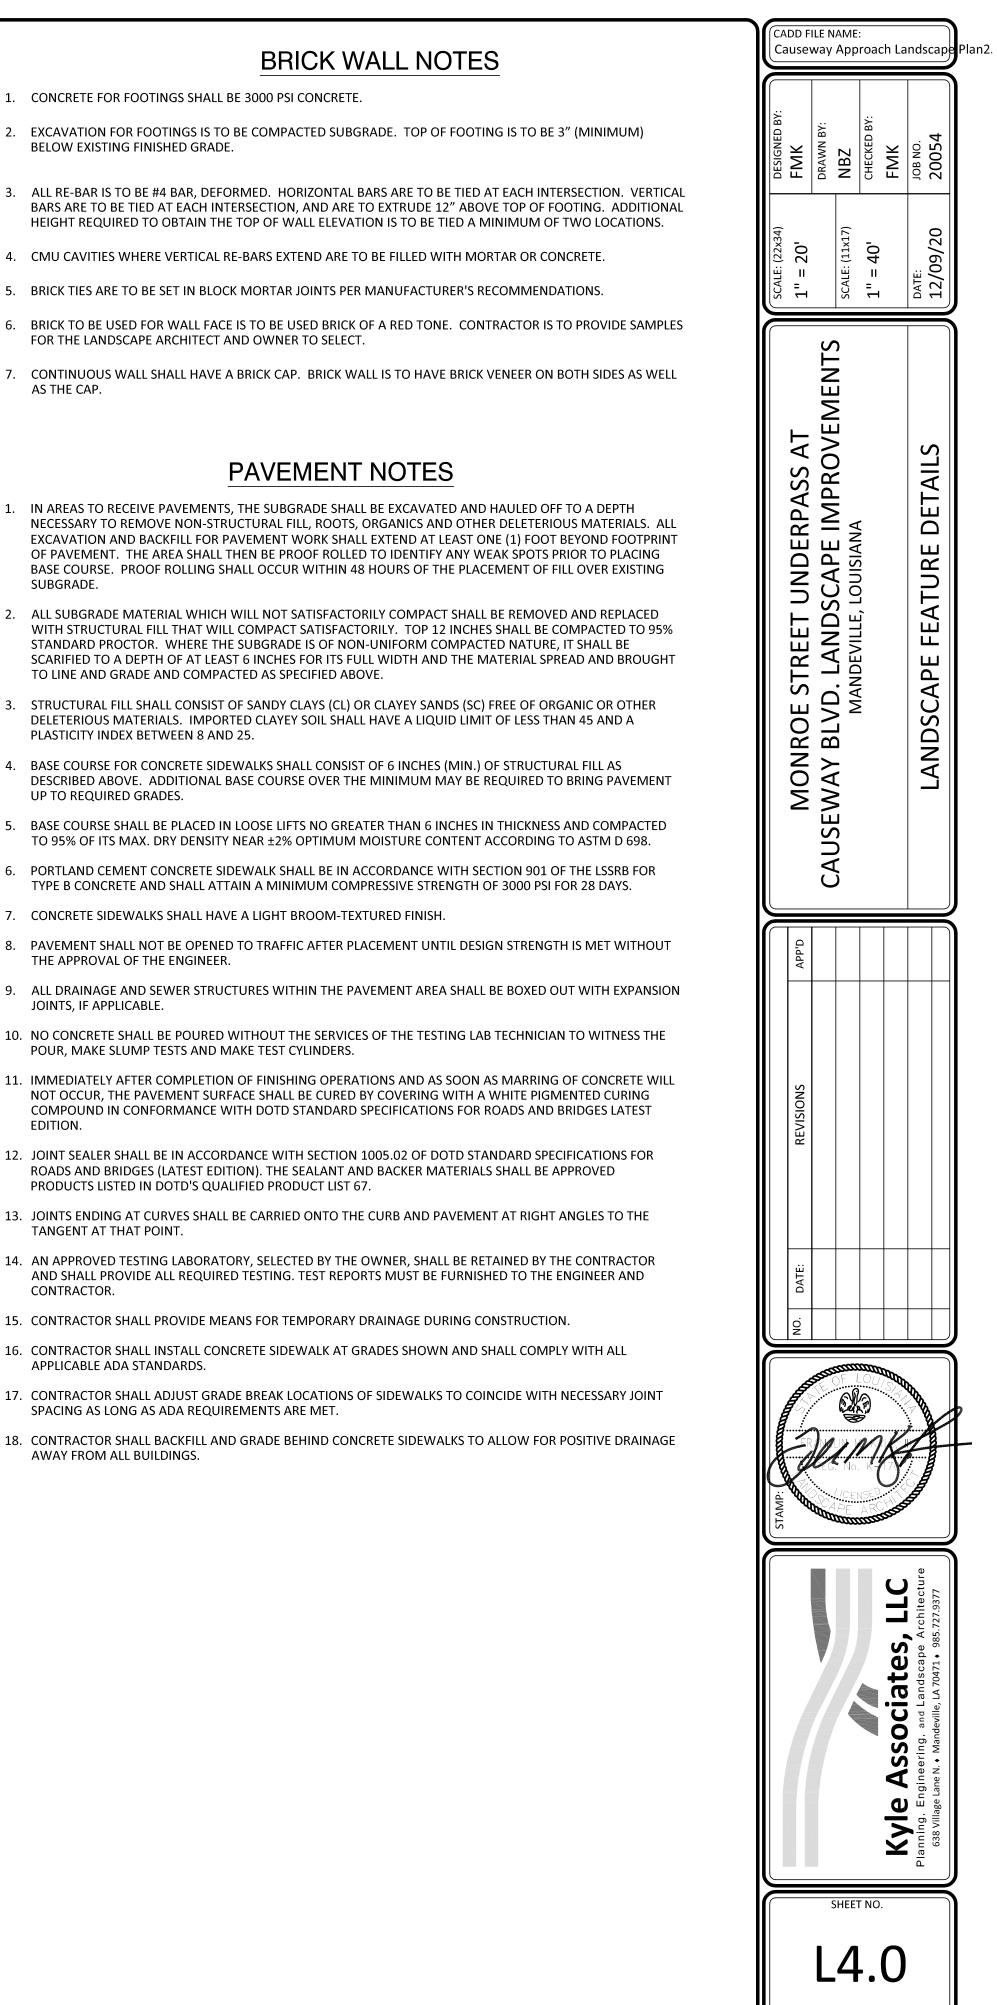
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SUBGRADE.


CONTRACTOR.

EDITION.

- APPLICABLE ADA STANDARDS.
- AWAY FROM ALL BUILDINGS.



MASTER LANDSCAPE PLAN MATERIALS SCHEDULE									
QUANTITY	BOTANICAL NAME	DESCRIPTION	ROOT (MIN.)	HEIGHT (MIN.)	SPREAD (MIN.)	CALIPER (MIN.)			
TREE									
3	Quercus Phellos	Willow Oak	B&B	10'-12'	6'-8'	2.5"	Well Branched		
1	Salix babylonica	Weeping Willow	B&B	12'-14'	8'-10'	3.0"	Well Branched		
15	Vitex agnus-castus	Vitex	B&B	8'-10'	6'-8'	2.5"	Well Branched		
SHRUBS									
34	Muhlenbergia capillaris	Pink Muhly Grass	3 gal	30"-36"	18"-24"	-	Full Material		
25	Panicum virgatum 'Shenandoah'	Shenandoah Switch Grass	3 gal	30"-36"	18"-24"	-	Full Material		
22	Pennisetum alopecuroides	Hameln Fountain Grass	3 gal	30"-36"	18"-24"	-	Full Material		
22	Pennisetum setaceum 'Rubrum'	Purple Fountain Grass	3 gal	30"-36"	18"-24"	-	Full Material		
30	Philodendron Selloum	Split Leaf Philodendron	5 gal	12"-16"	36"-42"	-	Full Material		
18	Rosa radrazz	Knock Out Rose	3 gal	24"-30"	24"-30"	-	Full Material		
GROUND COV	/ER	1			1	1			
838 s.y.	Eremochloa ophiuroides 'Oaklawn'	Centipede Sod	-	-	-	-	Installed in removal		
286 s.f.	Wedelia trilobata	Wedelia	1 gal	12"	12"	_	Plant on 2.5' Center		

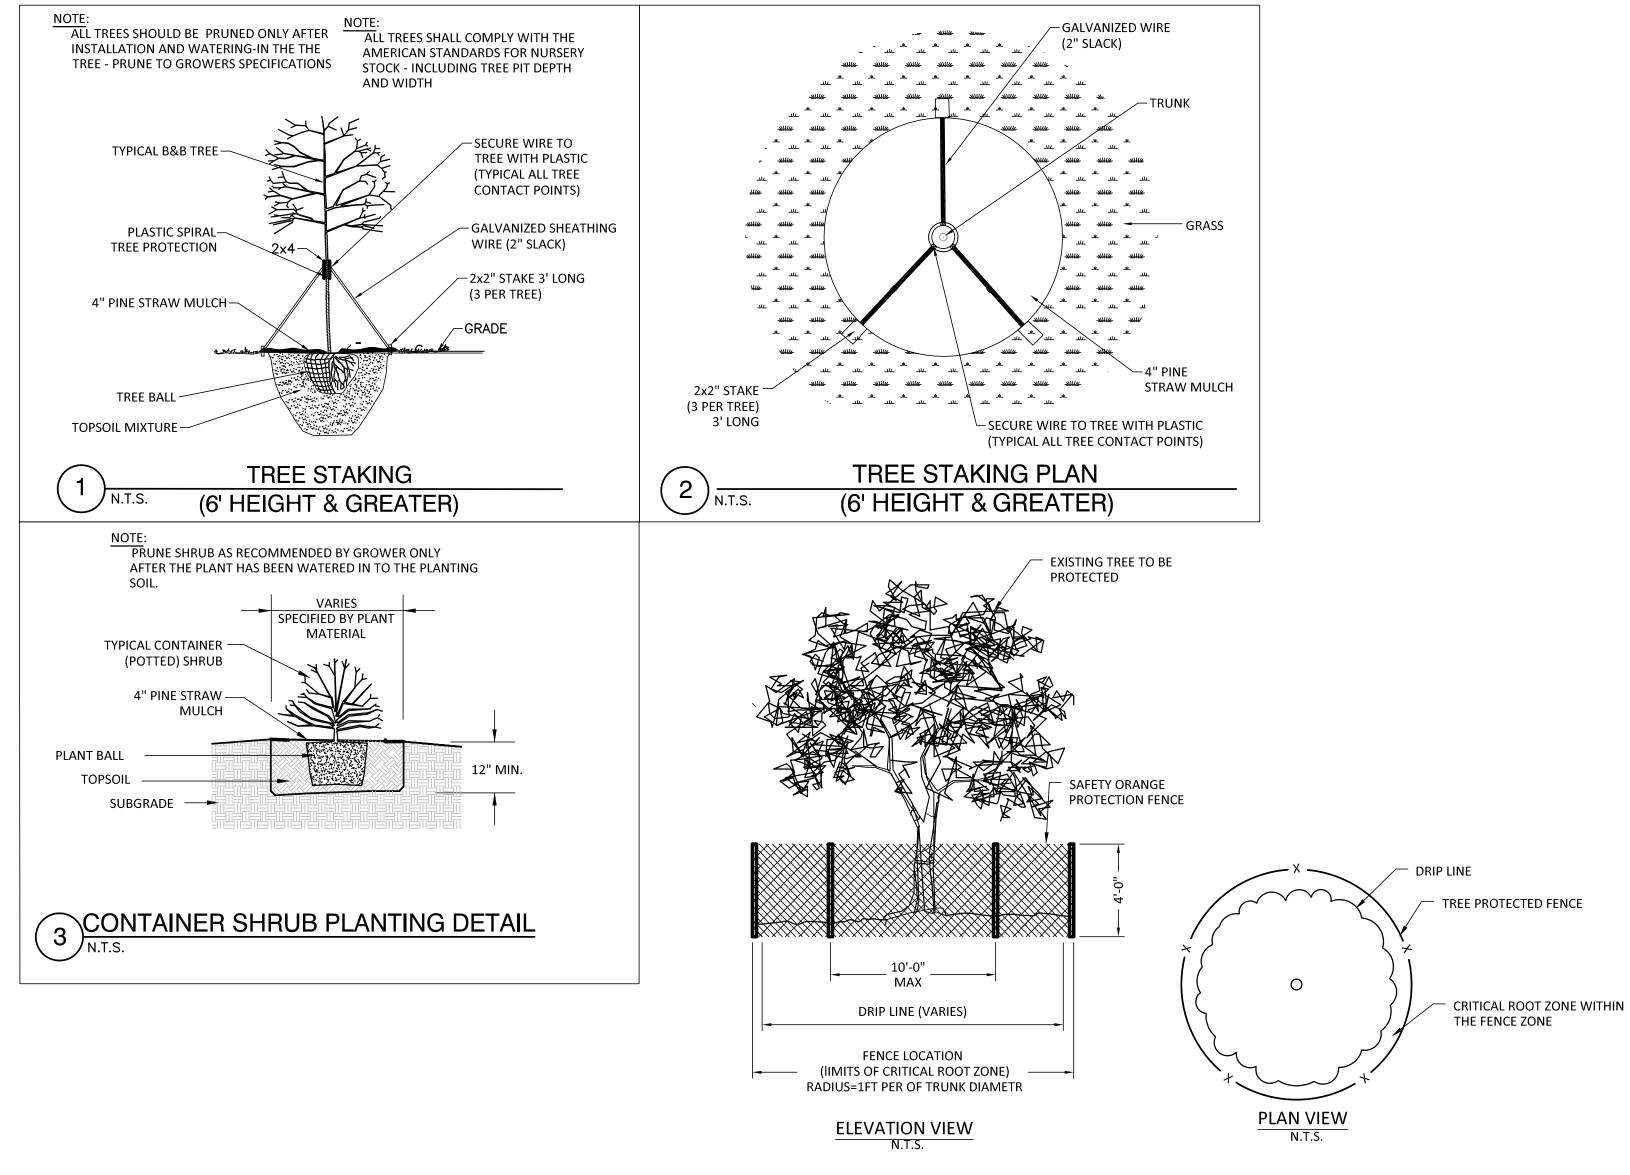



GENERAL NOTES

- 1. THE WORK PERFORMED UNDER THE DIRECTION OF THESE DOCUMENTS IS TO BE OF THE HIGHEST WORKMANSHIP AND QUALITY FOR WORK OF THIS TYPE. BEST INDUSTRY STANDARDS ARE TO BE APPLIED FOR ALL WORK DEFINED IN THESE DOCUMENTS.
- 2. THIS SET OF PLANS HAS BEEN DEVELOPED USING A SURVEY OR BASE INFORMATION PROVIDED BY THE OWNER. CONTRACTOR IS TO IMMEDIATELY NOTIFY THE LANDSCAPE ARCHITECT OF ANY DISCREPANCIES THAT EXIST BETWEEN THE SURVEY/BASE INFORMATION AND THE ACTUAL FIELD CONDITIONS.
- 3. THE PLAN REFLECTS A PROGRAM SET FORTH BY THE PROJECT OWNER. VARIATION IN PLANT SPECIES, SIZE, OR ARRANGEMENTS WILL NOT BE ALLOWED WITHOUT PRIOR WRITTEN APPROVAL BY THE LANDSCAPE ARCHITECT. ALL CORRESPONDENCE, ADDITIONS, SUBTRACTIONS, OR OTHER INSTANCES WHERE VARIATIONS IN THE PLAN MAY BE SUITABLE SHALL BE DIRECTED TO THE LANDSCAPE ARCHITECT IMMEDIATELY.
- 4. ALL WORK PERFORMED UNDER THESE DOCUMENTS IS TO BE DONE IN ACCORDANCE WITH THE LAWS AND REGULATIONS OF THE JURISDICTION IN WHICH THE PROJECT IS LOCATED. LOCAL, STATE, AND FEDERAL LAWS APPLY.
- 5. THE LANDSCAPE CONTRACTOR IS RESPONSIBLE FOR OBTAINING AND THE COST OF ALL PERMITS AND APPROVALS REQUIRED FOR THIS WORK. ONLY LICENSED AND INSURED LANDSCAPE CONTRACTORS WILL BE PERMITTED TO PERFORM THE WORK INDICATED ON THESE PLANS.
- 6. THE CONTRACTOR IS TO CONTACT THE LOCAL UTILITY LOCATION SERVICE PRIOR TO THE COMMENCEMENT OF WORK AND HAVE ALL SUBSURFACE UTILITIES MARKED ON THE GROUND SURFACE, INCLUDING BUT NOT LIMITED TO TELEPHONE, NATURAL GAS, CABLE, WATER, SEWER, DRAINAGE, AND FIBER OPTIC. DEPTH OF THE UTILITIES SHALL BE A CONSIDERATION IN THIS EVALUATION. ADJUSTMENTS REQUIRED TO THE LANDSCAPE PLAN OR IRRIGATION DESIGN AS A RESULT OF UTILITY CONFLICTS ARE TO BE MADE PRIOR TO THE COMMENCEMENT OF WORK
- 7. ALL EXISTING UTILITIES ARE TO BE PROTECTED AND MAINTAINED. REPAIRS ON UTILITIES DAMAGED BY THE CONTRACTOR WILL BE THE RESPONSIBILITY OF THE CONTRACTOR.
- 8. ALL EXISTING TREES AND OTHER LANDSCAPING THAT IS TO REMAIN, IS TO BE PROTECTED BY INSTALLING 4'ORANGE CONSTRUCTION SAFETY FENCING AROUND THE TREE AT THE DRIP LINE AND AROUND OTHER PLANTINGS AT THE EDGE OF THE PLANTED AREA.
- 9. EXISTING TREES AND SHRUBS THAT ARE INDICATED "TO BE REMOVED" ON THE PLANS SHALL BE CUT AND DISPOSED OF OFF SITE. THIS INCLUDES THE REMOVAL OF ALL ROOT SYSTEMS AND STUMPS (WHICH MAY BE GROUND) SO THAT THIS MATERIAL DOES NOT INTERFERE WITH THE NEW LANDSCAPE PROGRAM.
- 10. ALL CONSTRUCTION DEBRIS, INCLUDING BUT NOT LIMITED TO ROCKS, CONCRETE, BATTER BOARDS, PIPE, AND FOUNDATION BASE MATERIAL IS TO BE REMOVED FROM AREAS TO BE PLANTED PRIOR TO THE INSTALLATION OF BEDDING SOIL OR BASE PREPARATION FOR SOD.
- 11. UPON COMPLETION OF ALL BED PREPARATION, PLANTS ARE TO BE FULLY ARRANGED IN THE BED PRIOR TO INSTALLATION. THE LANDSCAPE ARCHITECT AND/OR THE OWNER ARE TO APPROVE THE ARRANGEMENT PRIOR TO PLANT INSTALLATION. THE LANDSCAPE CONTRACTOR IS TO ROTATE ALL TREE AND LARGE SHRUB MATERIAL AS TO MAXIMIZE THE BENEFIT OF THE BRANCHING STRUCTURE TOWARDS THE OUTWARD APPEARANCE. FAILURE TO OBTAIN SUCH APPROVAL MAY RESULT IN THE RELOCATION OF MATERIAL
- 12. ALL TREES ARE TO BE STAKED USING WOOD STAKES, THREE PER TREE GUY WIRES ARE TO BE GALVANIZED WITH PLASTIC SHEATHING AT ALL TREE CONTACT POINTS. GUY WIRES ARE TO BE SET WITH 2" SLACK TO ALLOW FOR TREE MOVEMENT. ALL WIRES ARE TO BE FLAGGED WITH HIGH VISIBILITY TAPE.

TREE PROTECTION MEASURES

- 1. NO CONSTRUCTION STAGING OR DISPOSAL OF MATERIALS OR BYPRODUCTS IS ALLOWED WITHIN THE TREE/ROOT PROTECTION ZONE.
- 2. ANY REQUIRED TRENCHING SHOULD BE ROUTED IN MANNER THAT MINIMIZES ROOT DAMAGE.
- 3. ANY WORK CONDUCTED IN THE GROUND WITHIN THE ROOT PROTECTED AREA OF ANY PROTECTED TREE SHOULD BE ACCOMPLISHED WITH HAND TOOLS.
- 4. PROTECTION FENCING OF MINIMAL WIDTH SHOULD GE INSTALLED.
- THE TREE/ROOT PROTECTION ZONE SHOULD BE IRRIGATED SUFFICIENTLY WITH CLEAN, POTABLE WATER TO KEEP THE TREE IN GOOD HEALTH.

BEDDING SOIL NOTES

- 1. BEDDING SOIL FOR ALL PLANTED AREAS WILL BE A MODIFIED SANDY LOAN SOIL SUITABLE FOR THE PLANT MATERIALS SELECTED.
- 2. ALL PLANTING AREAS WILL HAVE A MINIMUM OF 12" PLANTING MEDIUM, SLOPED DOWN TO THE EXISTING GRADE AT EACH LOCATION. A TRENCH AT THE BEDDING AREA EDGE IS TO BE EXCAVATED IN WHICH TO HOLD SELECTED MULCH.

Causeway Approach Landscape Plan2 PLANT MATERIAL NOTES 1. UPON APPROVAL OF THE TREE LOCATIONS, ALL EXISTING VEGETATION IN THESE AREAS IS TO BE CHEMICALLY ERADICATED USING A NON-SELECTIVE HERBICIDE (ROUND-UP OR EQUAL) APPLIED PER MANUFACTURER'S INSTRUCTIONS. PLANTING MEDIUM IS NOT TO BE PLACED IN THESE AREAS UNTIL THE CHEMICAL APPLICATION HAS SATISFACTORILY ELIMINATED THIS VEGETATION. 2. WHERE EXCAVATION REVEALS UNSUITABLE SOILS FOR PROPER TREE GROWTH, THE PLANTING HOLE IS TO BE DUG TWO TIMES THE SIZE OF THE ROOT BALL SPECIFIED, AND ALL BACKFILL IS TO BE TOPSOIL OR GARDEN MIX. UNSUITABLE MATERIAL IS TO BE REMOVED FROM THE SITE 3. UPON INSTALLATION OF PLANT MATERIAL, ALL TREE WELLS AND BEDDING AREAS ARE TO BE MULCHED WITH PINE STRAW MULCH, AS DIRECTED BY THE LANDSCAPE ARCHITECT AND/OR OWNER. MULCH SHALL BE A MINIMUM OF 4" THICK. 4. ALL PLANT MATERIAL SPECIFIED IS TO BE FREE OF ALL PESTS, DISEASE, ш AND OTHER FOREIGN MATTER UPON DELIVERY TO THE SITE. MATERIAL SHOULD COME FROM A REPUTABLE AND LICENSED NURSERY WITHIN THE REGION WHERE THE PROJECT EXISTS. ANY PLANT THAT DOES NOT ш MEET THESE REQUIREMENTS OR IS NOT IN EXCELLENT HEALTH WILL BE REJECTED. Ó 2 Ā 5. ALL PLANT MATERIAL WILL MEET OR EXCEED THE MINIMUM SIZES S IMPI INDICATED IN THE PLANT MATERIAL SCHEDULE. ADDITIONALLY, ALL CONTAINER PLANT MATERIAL IS TO HAVE BEEN IN THE CONTAINER SIZE RP SPECIFIED FOR A MINIMUM OF ONE FULL GROWING SEASON. THE \square LANDSCAPE ARCHITECT RESERVES THE RIGHT TO REFUSE MATERIAL IN ШША ∞ THE EVENT THESE MINIMUM STANDARDS ARE NOT MET. S 6. PLANT MATERIAL DELIVERED TO THE PROJECT SITE IS NOT TO BE STOCKPILED FOR MORE THAN THREE DAYS. THE CONTRACTOR IS FULLY RESPONSIBLE FOR THE HEALTH AND WELL BEING OF ALL LANDSCAPE Ó MATERIAL STAGED ON SITE. ĹIJ Z ш 7. ALL PLANT MATERIAL IS TO BE FERTILIZED AT THE TIME OF PLANTING TR WITH A BALANCED, TIME RELEASED FERTILIZER SUITABLE FOR THE ٩ SPECIFIC PLANT MATERIAL INSTALLED. FERTILIZATION FOR MATERIAL IN Ś 4 PLANTING AREAS MAY BE INCORPORATED INTO THE SOIL MIX OR ш APPLIED AT EACH PLANT LOCATION. S Ο 8. THE LANDSCAPE CONTRACTOR IS TO APPLY A WEED INHIBITOR ON THE 2 Ξ Ζ SURFACE OF ALL PLANTING AREAS PRIOR TO MULCHING, OR AS PER Z ≻ 4 MANUFACTURER'S INSTRUCTIONS. D A 9. THE SCOPE OF THIS PROJECT INCLUDES THE PRUNING AND MAINTENANCE OF ALL MATERIAL (IMMEDIATELY AFTER PLANTING). PLANT MATERIAL IS TO HAVE THE HIGHEST QUALITY APPEARANCE AT S THE TIME OF FINAL PRODUCT ACCEPTANCE. 10. IT IS THE RESPONSIBILITY OF THE LANDSCAPE CONTRACTOR TO WATER ALL MATERIAL THOROUGHLY UPON INSTALLATION, EVERY DAY FOR THE FIRST THREE DAYS FROM PLANTING, THEN EVERY OTHER DAY FOR THE NEXT TEN DAYS. THIS REQUIREMENT WILL BE WAIVED ONCE AN IRRIGATION SYSTEM IS INSTALLED AND OPERATIONAL. 11. CONTRACTOR IS TO WARRANT THE SURVIVABILITY OF ALL PLANT MATERIAL FOR ONE YEAR AFTER ACCEPTANCE, WITH EXCEPTIONS BEING MADE FOR FREEZE, WIND DAMAGE, AND VEHICULAR DAMAGE. DROUGHT IS EXCLUDED. **IRRIGATION NOTES** 1. THE LANDSCAPE CONTRACTOR IS TO PROVIDE A SCHEMATIC IRRIGATION SYSTEM DESIGN WHICH INDICATES THE HEAD LOCATIONS, PIPING DIAGRAM, PIPE SIZES, VALVE LOCATIONS, AND WATER SOURCE CONNECTION. THIS PLAN IS TO REFLECT THE LANDSCAPE PLANTING PLAN INCLUDED AS A PART OF THIS SET. THE IRRIGATION PLAN IS TO BE SUBMITTED TO THE LANDSCAPE ARCHITECT FOR APPROVAL PRIOR TO AN WORK BEING COMMENCED. SPRAY HEAD OR DRIP APPLICATION SYSTEMS ARE PERMITTED. 2. ALL LANDSCAPE INSTALLATION WORK IS TO BE COORDINATED WITH THE IRRIGATION SYSTEM. THE IRRIGATION CONTRACTOR IS RESPONSIBLE FOR THE ADJUSTMENT OF SPRAY HEADS AND NOZZLES TO FIT THE PLANT MATERIAL FOR THE PROJECT. 3. THE WATER SOURCE FOR THIS PROJECT IS TO BE THE MUNICIPAL WATER SYSTEM SERVING THE SITE. ALL CONNECTIONS TO THE SYSTEM ARE TO BE IN CONFORMANCE WITH THE RULES AND REGULATIONS GOVERNING WATER CONNECTIONS FOR IRRIGATION SYSTEMS IN THE JURISDICTION IN WHICH THIS PROJECT EXISTS. A BACKFLOW PREVENTER IS TO BE INSTALLED AT THE POINT OF WATER SOURCE CONNECTION, PER LOCAL CODES. 4. COVERAGE OF ALL BED AREAS IS TO BE 100%. THE IRRIGATION/LANDSCAPE CONTRACTOR IS TO ENSURE THAT DIRECT OR OVERSPRAY FROM IRRIGATION HEADS IS NOT PERMITTED TO WET WALKWAYS OR BE A DETRIMENT TO ADJACENT STREETS OR DRIVES. 5. ONLY TORO, RAIN BIRD, OR HUNTER IRRIGATION PRODUCTS (OR APPROVED EQUAL) WILL BE PERMITTED. THE LANDSCAPE CONTRACTOR IS TO PROVIDE SUBMITTALS ON ALL PRODUCTS TO BE USED IN THE IRRIGATION SYSTEM. 6. THE IRRIGATION SYSTEM MAY MAKE USE OF SPRAY HEADS, DRIP EMITTERS, SOAKER HOSES, OR ANY COMBINATION THEREOF. THE SYSTEM WILL BE A FULLY AUTOMATED SYSTEM WITH INITIAL SET-UP MADE BY THE LANDSCAPE/IRRIGATION CONTRACTOR. 7. IRRIGATION SYSTEM ZONES ARE TO BE HYDRAULICALLY DESIGNED FOR A WATER SOURCE WITH AN OPERATING PRESSURE OF 55 PSI AND A FLOW RATE OF 40 GALLONS PER MINUTE. SYSTEM SHALL BE CONFIGURED TO S HAVE NO MORE THAN TWO ZONES OPERATING AT ONE TIME. FOR LARGE te SYSTEMS WHERE THESE PARAMETERS ARE NOT ADEQUATE, THE CONTRACTOR WILL REQUEST FROM THE LANDSCAPE ARCHITECT י 👘 🌒 PARAMETER VARIANCES. oci 8. THE IRRIGATION SYSTEM CONTROLLER IS TO BE LOCATED IN AN INCONSPICUOUS LOCATION, AS DIRECTED BY THE OWNER. A 1110V POWER S SUPPLY SHALL BE PROVIDED BY THE OWNER, AS NEEDED. S 9. ALL PIPING IS TO BE PVC CLASS 200 FOR LATERAL, SYSTEM, AND ZONES LINES. ALL MAIN LINE (CONTINUALLY CHARGED) PIPING IS TO BE PVC Ð SCHEDULE 40. LINES ARE TO BE BURIED A MINIMUM OF 16" DEEP. ALL LINES ARE TO BE FLUSHED PRIOR TO THE INSTALLATION OF IRRIGATION HEADS. SHEET NO. 15.0

CADD FILE NAME: